





810 7th St NE WASHINGTON D.C. 20002 SUITE 2-103 Ph. 240-408-0531

4402 GEORGIA **AVE NW**

4402 GEORGIA AVE NW WASHINGTON DC 20011LOT 0089 SQUARE 2917


OWNER / DEVELOPER

CIVIL ENGINEER, DASOL

STRUCTURAL ENGINEER DASOL

Issue


Revisions

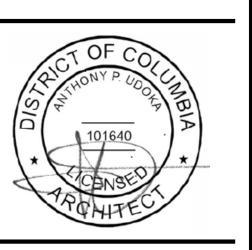


AXONOMETRIC VIEWS

PRINCIPAL IN CHARGE Negussu Solomon

DATE Issue Date SCALE: JOB NO. Project Number

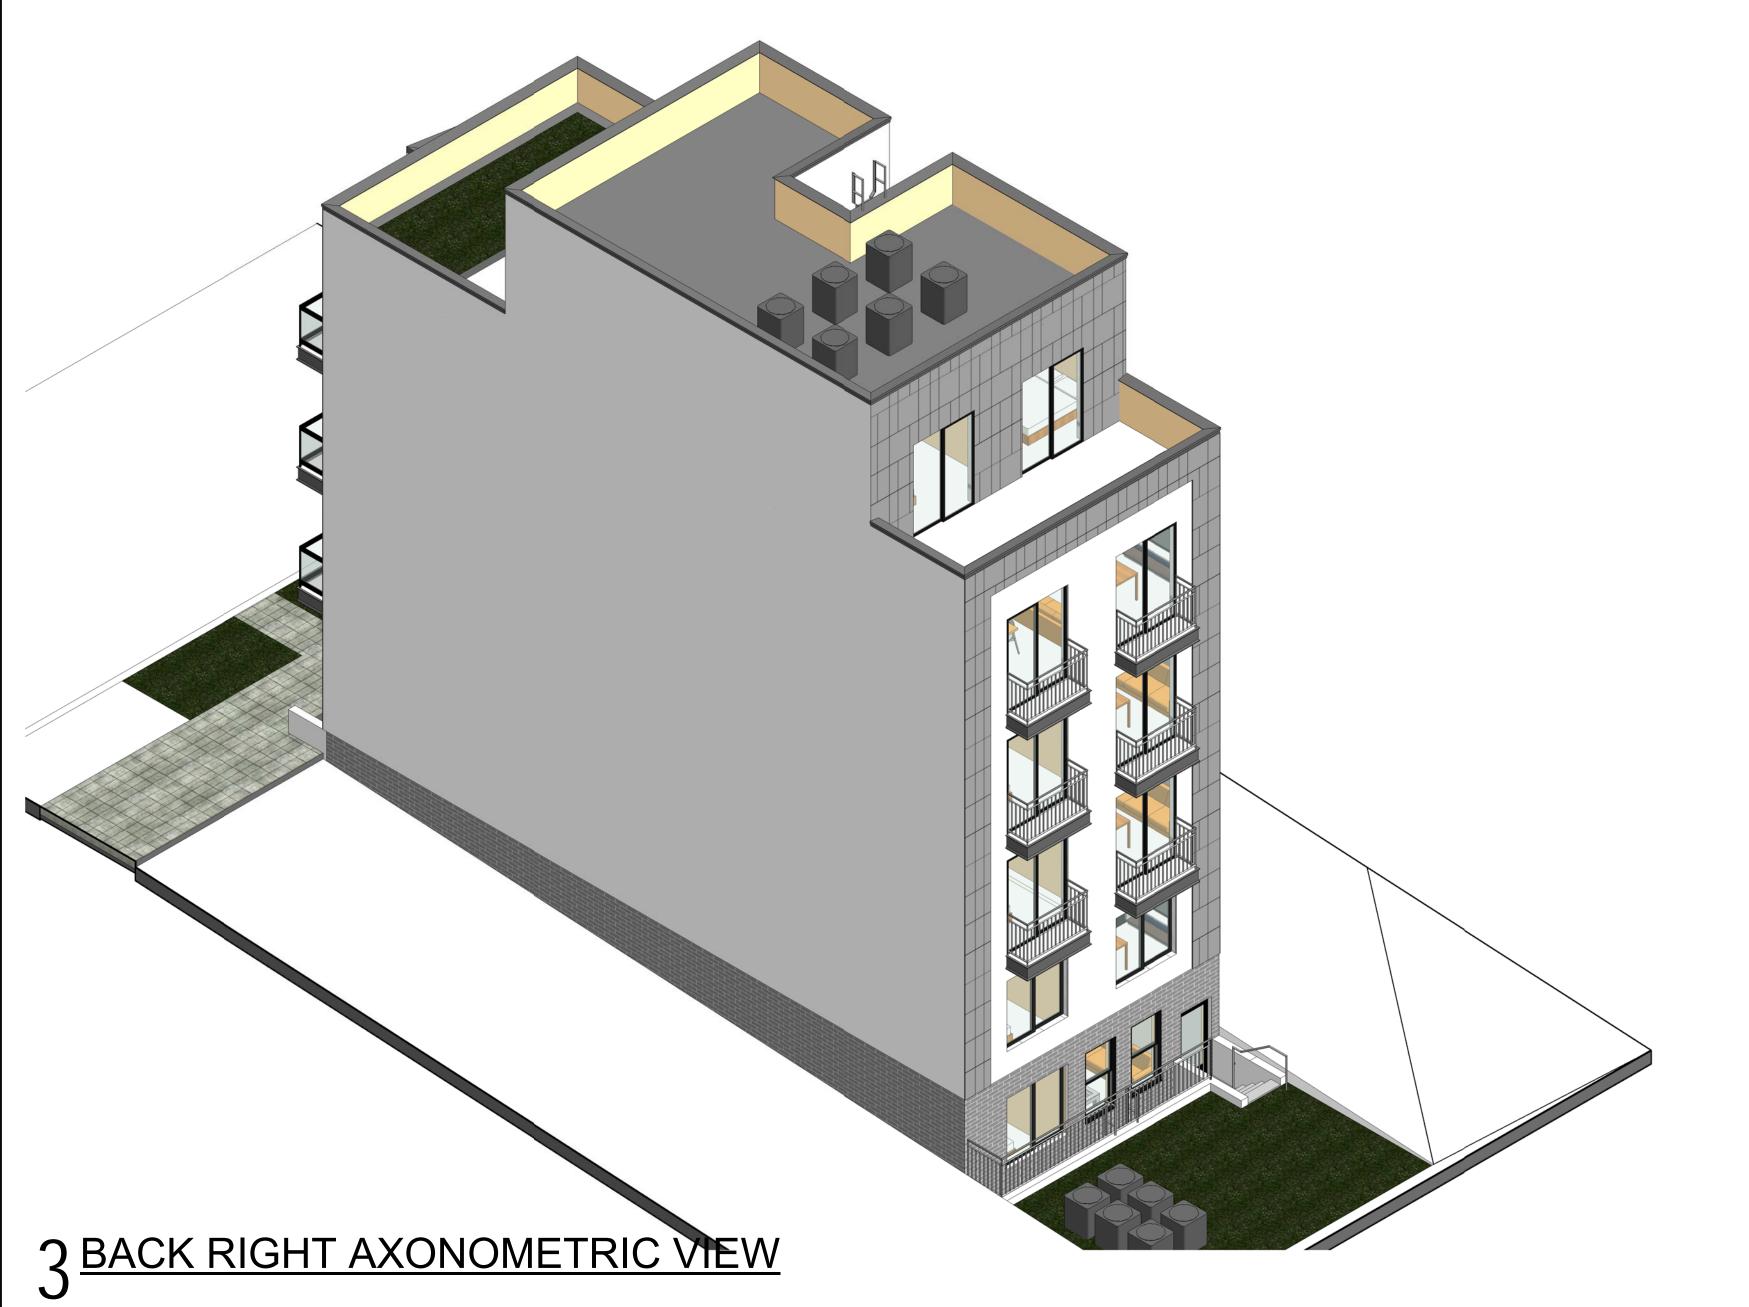

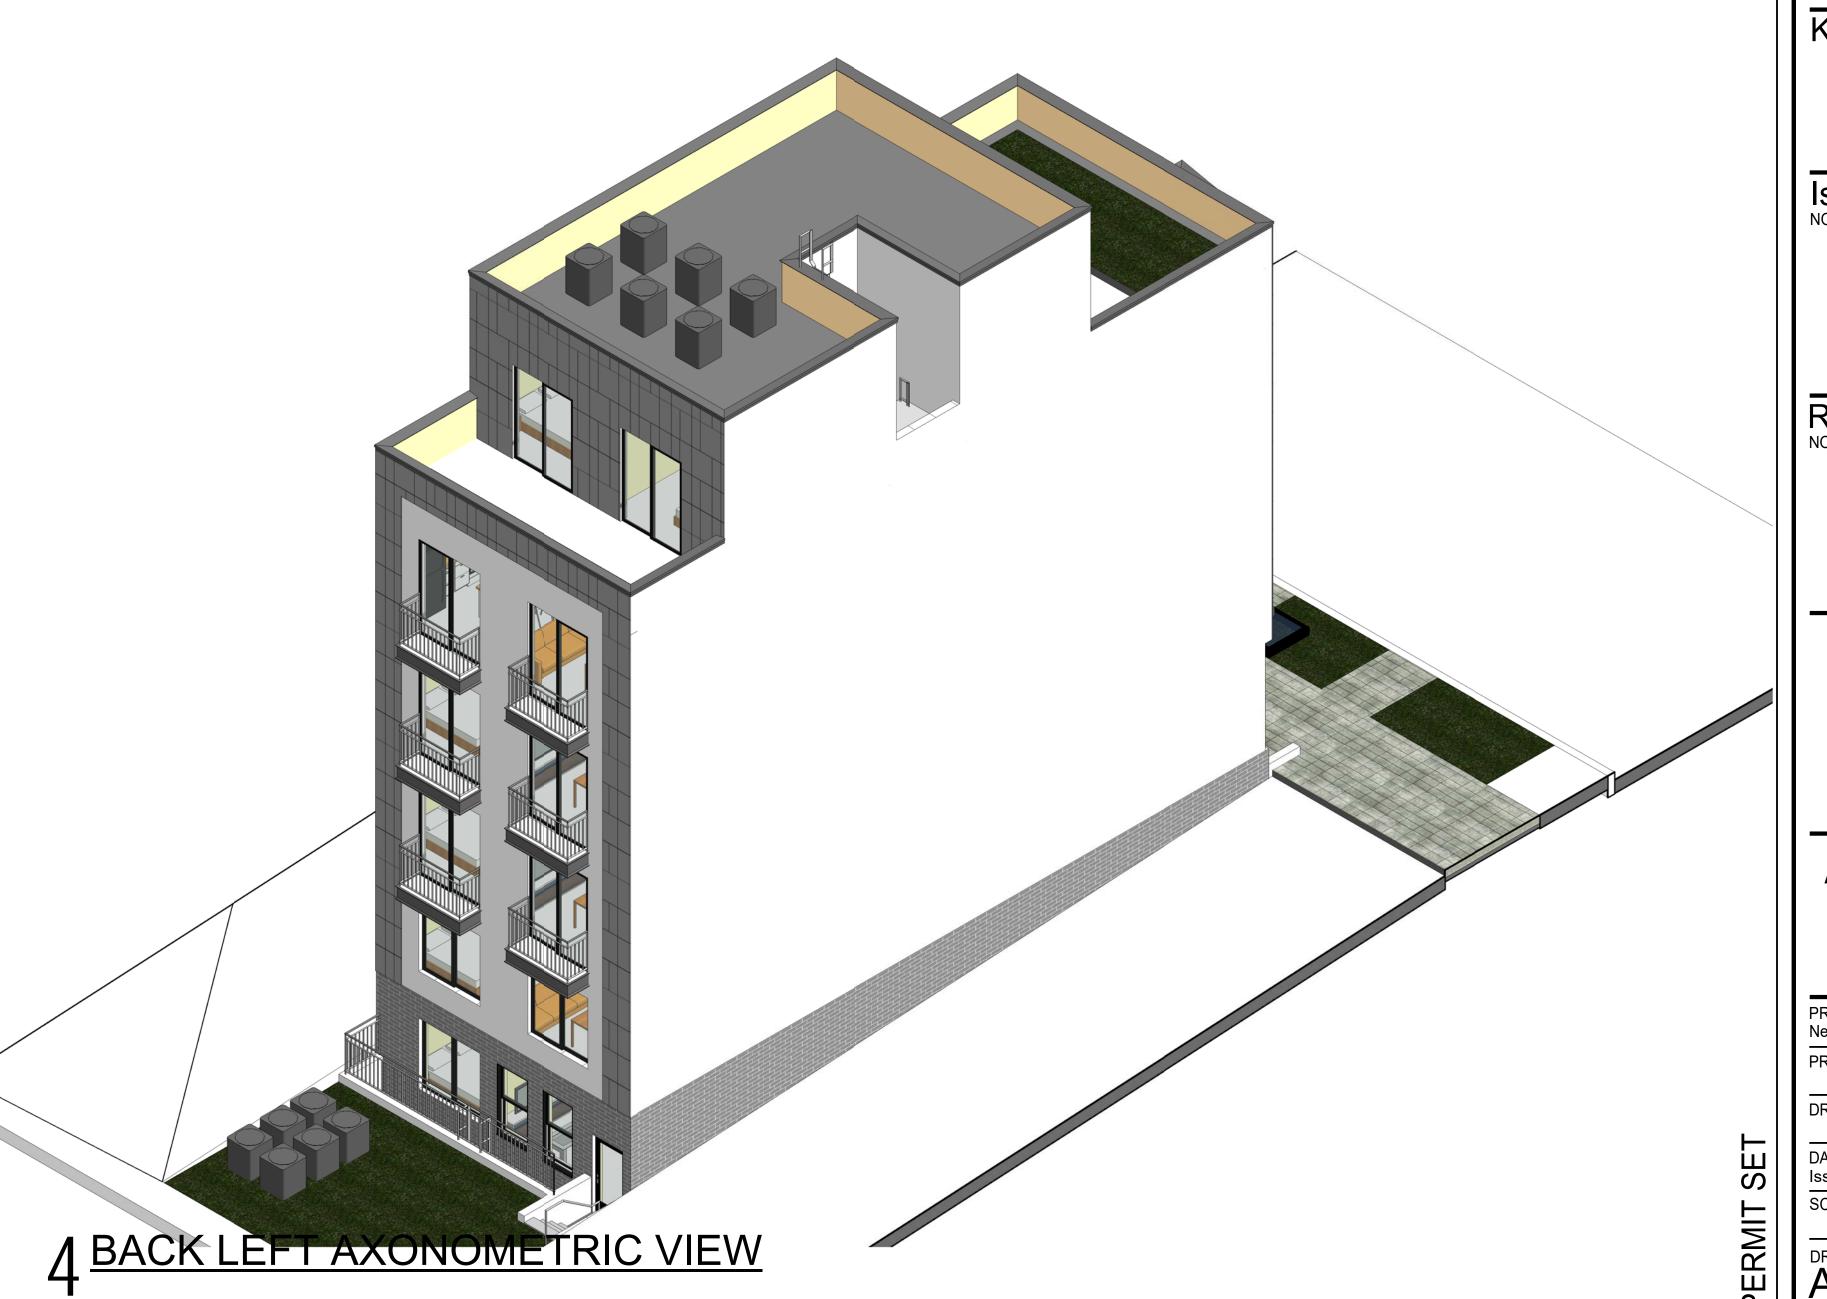

PROJECT ADDRESS

PROJECT: 4402 GEORGIA AVE NW

LOCATION: 4402 GEORGIA AVE NW WASHINGTON DC 20011

SCOPE OF WORK

RAZE OF AN EXISTING 2 STORY BUILDING AND CONSTRUCTION OF A NEW 4 STORY + CELLAR AND BASEMENT APARTMENT BUILDING. THERE WILL BE A TOTAL OF (12) CONDOMINIUM UNITS.

APPLICABLE CODES

THIS PROJECT CONFORMS TO ALL APPLICABLE BULDING CODES AND ZONING REGULATIONS FOR THE DISTRICT OF COLUMBIA. ALL CODES SUBJECT TO THE DISTRICT OF COLUMBIA CONSTRUCTION CODES 2017 SUPPLEMENT AMMENDMENTS AND ALL REVISIONS.

2015 ENERGY CONSERVATION CODE
2015 FIRE CODE
2015 MECHANICAL CODE
2015 PLUMBING CODE
2015 PROPERTY MAINTENANCE CODE
2015 FUEL GAS CODE
2015 EXISTING BUILDING CODE
2015 ELECTRICAL CODE
DCMR TITLE 11 - ZONING REGULATIONS
ICC/ANSI A117.1 2009
2012 INTERNATIONAL GREEN CONSTRUCTION CODE

2015 INTERNATIONAL BUILDING CODE

ZONING ANALYSIS

BASED ON DCMR TITLE 11 DC ZONING REGULATION PROPOSED 12 DWELLING UNITS

SQUARE	LOT	ZONE	LOT SIZE
2917	0089	MU-4	2100 SQ. FT.

	ALLOWABLE	PROPOSED
LOT OCCUPANCY	75% (1,575)	75% (1,575)
F.A.R	3 (6,300 SF)	2.96 (6,285 SF)
REAR YARD SETBACK	15 FT	21 FT
BUILDING HEIGHT	50 FT	46 FT
LONG TERM BIKE PARKING	1 SPACE / 3 DWELLING UNITS	4
SHORT TERM BIKE PARKING	1 SPACE / 20 DWELLING UNITS	1

CLASSIFICATION	
USE GROUP	R-2
CONSTRUCTION TYPE	3 - A
SPRINKLER SYSTEM	NFPA 13
FIRE ALARM SYSTEM	YES, Automatic with the Sprinkler System
AUTOMATIC SMOKE DETECTION SYSTEM	YES
STAND PIPE	Y, CLASS I
AREA LIMITATON	
ALOWABLE AREA (IBC TABLE 503)	24,000
FRONTAGE INCREASE (IBC 506.2)	N/A
AUTOMATIC SPRINKLER INCREASE (IBC 506.3)	0
TOTAL ALLOWABLE AREA	24,000
HEIGHT LIMITATION	
ALLOWABLE HEIGHT (IBC TABLE 503)	60, 4 STORIES
AUTOMATIC SPRINKLER INCREASE (IBC 504.2)	0
TOTAL ALLOWABLE HEIGHT	60
TOTAL PROPOSED HEIGHT	46, 4 STORIES

COMPLIANCE WITH 2017 DC ENERGY CONSERVATION CODE

0.0189 U-Factor	R-54
0.058 U-Factor	R-15 + R-4.1
0.092 U-Factor	R-11
0.03 U-Factor	R-33
0.052 U-Factor	R-20
0.45 U-Factor	
0.33 U-Factor	SHGC - 0.36
0.45 U-Factor	SHGC - 0.36
	0.058 U-Factor 0.092 U-Factor 0.03 U-Factor 0.052 U-Factor 0.45 U-Factor 0.33 U-Factor

FIRE PROTECTION IBC TABLE 601 FIRE RESISTANCE RATING REQUIREMENTS FOR BLDG ELEMENTS FIRE RESISTANCE RATING - CONSTRUCTION TYPE IIIA (3 - A) BUILDING ELEMENT LOCATION RATING

	FIRE RESISTANCE RATING - CONSTRUC	CTION TYPE IIIA (3 - A)	
	BUILDING ELEMENT	LOCATION	RATING
	PRIMARY STRUCTURAL FRAME		1 HR
	BEARING WALLS	EXTERIOR	2 HR
		INTERIOR	1 HR
NON - BEARING WALLS & PARTITIONS		EXTERIOR	SEE IBC TABLE 602
	PARTITIONS	INTERIOR	0 HR
	FLOOR CONSTRUCTION & ASSOC.SECONDARY MEMBERS		1 HR
	ROOF CONSTRUCTION & ASSOC.SECONDARY MEMBERS		1 HR

IBC TABLE 602 FIRE-RESISTANCE RATING REQUIREMENTS FOR EXTERIOR WALLS BASED ON FIRE SEPARATION DISTANCE

FIRE SEPARATION DISTANCE	RATING
X < 5'-0"	1
5'-0" <x<10'-0"< td=""><td>1</td></x<10'-0"<>	1
10'-0" < X < 30'-0"	1
X >_ 30'-0"	0

IBC TABLE 705.8 MAXIMUM AREA OF EXTERIOR WALL OPENINGS BASED ON FIRE SEPARATION DISTANCE AND DEGREE OF OPENING PROTECTION

FIRE SEPARATION DISTANCE (FEET)	DEGREE OF OPENING PROTECTION	ALLOWABLE AREA
	UP,NS	NOT PERMITTED
0 TO LESS THAN 3	UP,S	NOT PERMITTED
	Р	NOT PERMITTED
	UP,NS	NOT PERMITTED
3 TO LESS THAN 5	UP,S	15%
	Р	15%
	UP,NS	10%
5 TO LESS THAN 10	UP,S	25%
	Р	25%
	UP,NS	15%
10 TO LESS THAN 15	UP,S	45%
	Р	45%
	UP,NS	25%
15 TO LESS THAN 20	UP,S	75%
	Р	75%
	UP,NS	45%
20 TO LESS THAN 25	UP,S	NO LIMIT
	Р	NO LIMIT
	UP,NS	70%
25 TO LESS THAN 30	UP,S	NO LIMIT
	Р	NO LIMIT
	UP,NS	NO LIMIT
30 OR GREATER	UP,S	NOT REQUIRED
	Р	NOT REQUIRED

*UP = UNPROTECTED, P = PROTECTED, NS = NONSPRINKLERED, S = SPRINKLERED

GREEN BUILDING

GREEN BUILDING PROGRAM MANUAL:

GREEN BUILDING ACT SELF SELECTION GUIDE

The project is new construction > that is not publicly owned or financed > and is less than 50,000 SF --- Green Building Act does not apply

GREEN CONSTRUCTION CODE SELF SELECTION GUIDE
The project is new construction > that is not required to comply with Green Building Act>
and is more than 1 0,000 SF > the project is residential > the project is not single family
and is not less than 3 stories --- Green Construction Code does apply and 15 electives
will be selected from Appendix A

OCCUPANCY LOAD (IBC TABLE 1004.1.2)	RESIDENTIAL (OCCUPANT LOAD FACTOR 200 GROSS)	7 OCCUPANTS PER FLR.
EGRESS WIDTH PER OCCUPANT	STAIRWAYS	.2" (WITH AUTOMATIC SPRINKLER)
(IBC SECTION 1005	OTHER	.1 5" (WITH AUTOMATIC SPRINKLER)
EXIT ACCESS	EXIT SEPARATION (IBC SECTION 1 015.2.1)	1/4 OF LENGTH OF DIAGONAL DIMENSION OF AREA SERVED, MIN.
	TRAVEL DISTANCE (IBC TABLE 101 6.2)	250' (WITH AUTOMATIC SPRINKLER)
	COMMON PATH OF TRAVEL (IBC TABLE 1014.3)	125' (WITH AUTOMATIC SPRINKLER)
CORRIDORS	WIDTH (IBC TABLE 1 018.2)	44" MINIMUM 24" FOR MECHANICAL ACCESS 36" FOR < 50 OCCUPANTS 36" WITHIN DWELLING UNIT
	DEAD END CORRIDOR (SECTION 1018.4)	50' MAXIMUM
EXITS	NUMBER OF EXITS	2 EXITS
30 OR GREATER	WIDTH (IBC 1009.4)	44" MINIMUM 36" FOR < 50 OCCUPANTS

RED # OF UNITS

# of Bedrooms	Area	Level	Comments	
1 BED RM. + DEN	725 SF	BASEMENT LEVEL		
1 BED RM. + DEN	472 SF	BASEMENT LEVEL		
1 BED RM. + DEN	572 SF	CELLAR LEVEL		
1 BED RM. + DEN	385 SF	CELLAR LEVEL		
1 BED RM.	593 SF	FIRST FLOOR	ACCESSIBLE UNIT	
1 BED RM. + DEN	451 SF	FIRST FLOOR	ACCESSIBLE UNIT	
1 BED RM. + DEN	791 SF	SECOND FLOOR		
1 BED RM. + DEN	494 SF	SECOND FLOOR		
1 BED RM. + DEN	791 SF	THIRD FLOOR		
1 BED RM. + DEN	494 SF	THIRD FLOOR		
2 BED RM. TOTAL	791 SF	FOURTH FLOOR		
2 BED RM. TOTAL	494 SF	FOURTH FLOOR		
	463 SF	PENTHOUSE FLOOR		
	1 4 00 01		1	
	# of Bedrooms 1 BED RM. + DEN 2 BED RM. + DEN	# of Bedrooms	1 BED RM. + DEN 725 SF BASEMENT LEVEL 1 BED RM. + DEN 472 SF BASEMENT LEVEL 1 BED RM. + DEN 572 SF CELLAR LEVEL 1 BED RM. + DEN 385 SF CELLAR LEVEL 1 BED RM. 593 SF FIRST FLOOR 1 BED RM. + DEN 451 SF FIRST FLOOR 1 BED RM. + DEN 791 SF SECOND FLOOR 1 BED RM. + DEN 494 SF SECOND FLOOR 1 BED RM. + DEN 791 SF THIRD FLOOR 1 BED RM. + DEN 494 SF THIRD FLOOR 2 BED RM. TOTAL 791 SF FOURTH FLOOR 2 BED RM. TOTAL 494 SF FOURTH FLOOR 2 BED RM. TOTAL 494 SF FOURTH FLOOR	

Area Schedule (Gross Building)

Name Level Area F.A.R	
BASEMENT LEVEL	
BASEMENT LEVEL BASEMENT LEVEL 1567 SF 0 SF	
CELLAR LEVEL	
CELLAR LEVEL 1567 SF 0 SF	
FIRST FLOOR	
FIRST FLOOR FIRST FLOOR 1556 SF 1556 SF	
SECOND FLOOR	
SECOND FLOOR SECOND FLOOR 1575 SF 1575 SF	
BAY PROJECTION SECOND FLOOR 33 SF 0 SF	
THIRD FLOOR	
THIRD FLOOR THIRD FLOOR 1575 SF 1575 SF	
BAY PROJECTION THIRD FLOOR 33 SF 0 SF	
FOURTH FLOOR	
THIRD FLOOR FOURTH FLOOR 1575 SF 1575 SF	
BAY PROJECTION FOURTH FLOOR 33 SF 0 SF	
PENTHOUSE FLOOR	
PENTHOUSE LEVEL PENTHOUSE FLOOR 838 SF 0 SF	
TOTAL <u>10,347 SF</u> <u>6,281 SF</u>	



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STRUCTURAL ENGINEER


DASOL

Key Plan

ssue

Revisions

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Revision 1

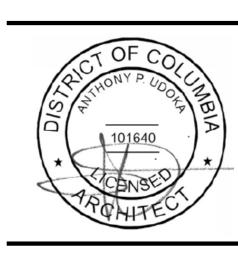


CODE ANALYSIS


PRINCIPAL IN CHARGE Negussu Solomon PROJECT ARCHITECT

DRAWN

DATE APPROVED Issue Date
SCALE: JOB NO. Project Number

DRAWING NO.

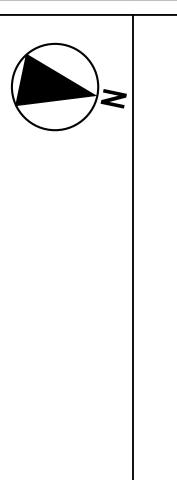

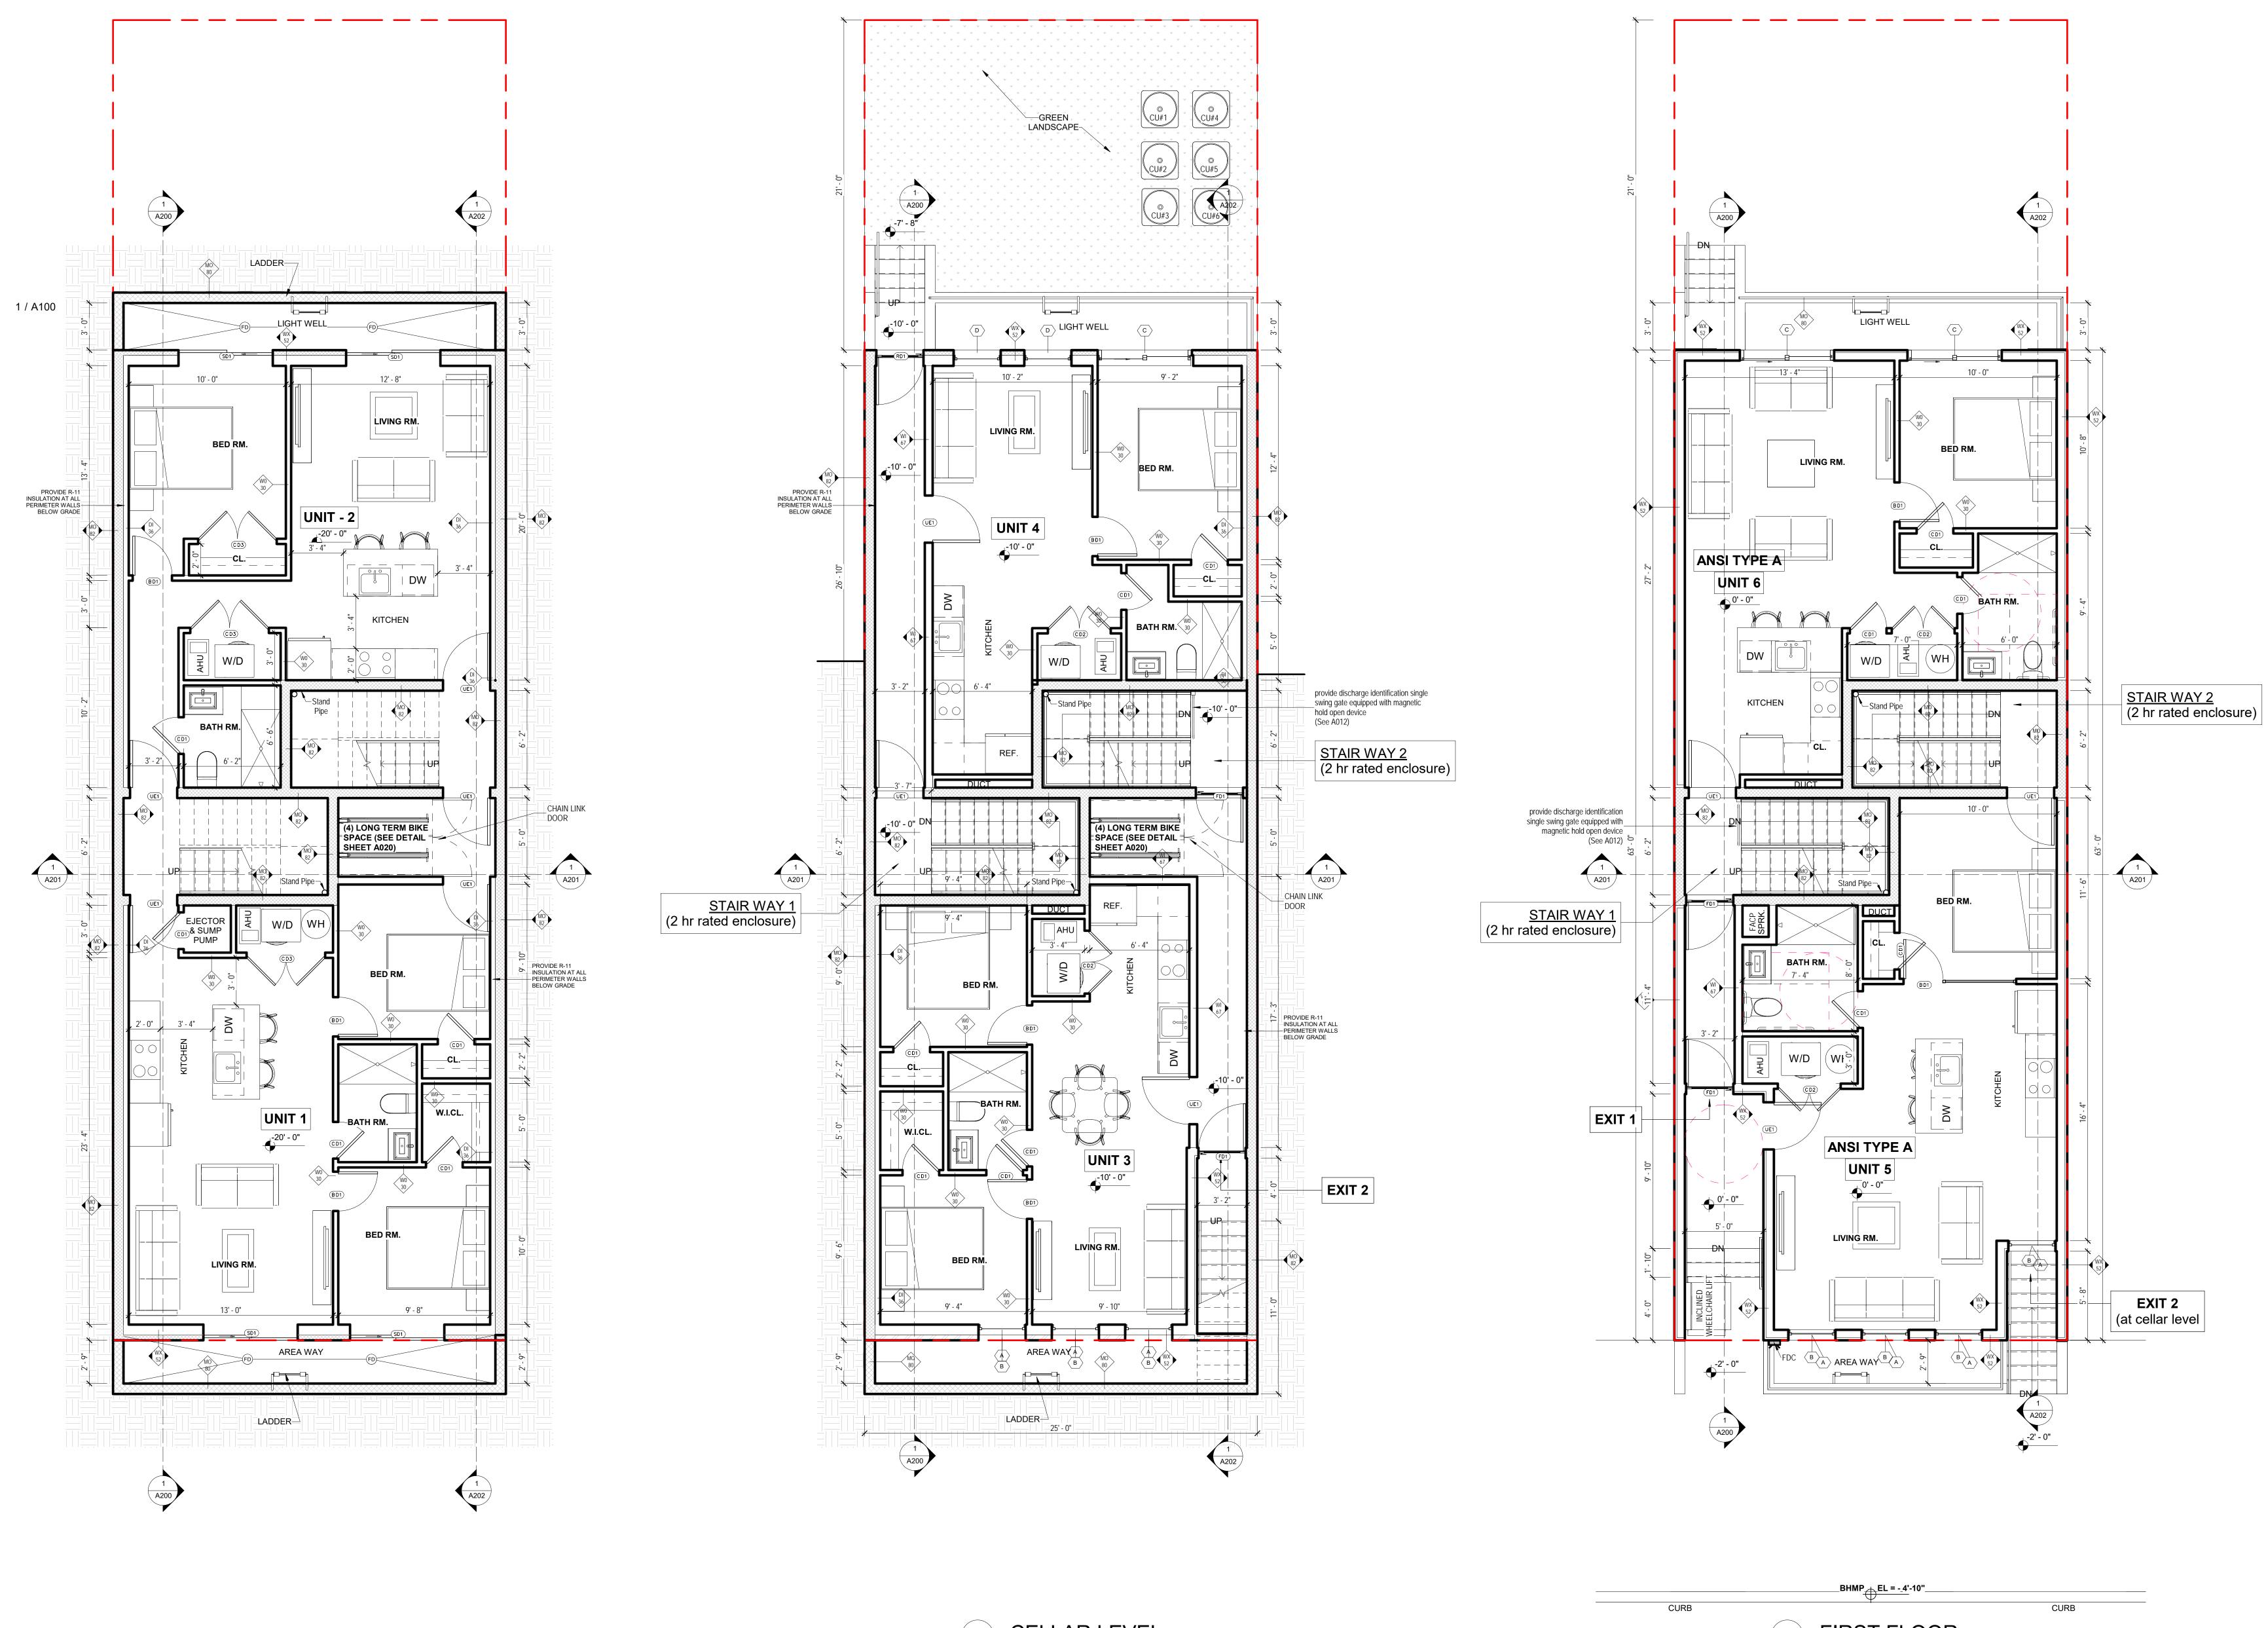

2 CELLAR LEVEL 1/4" = 1'-0" 3 FIRST FLOOR 1/4" = 1'-0" DASOL ENGINEERS ARCHITECTS

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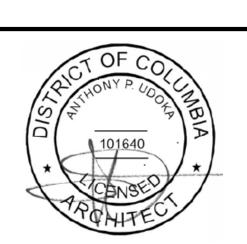
DASOL

Key Plan

Issue

NO. DATE

Revisions DATE



ARCHITECTURAL PLAN

PRINCIPAL IN CHARGE
Negussu Solomon
PROJECT ARCHITECT
DRAWN


DATE APPROVED Issue Date SCALE: JOB NO.
1/4" = 1'-0" Project Number

1/4" = 1'-0"

DRAWING NO.


A100

1 BASEMENT LEVEL
1/4" = 1'-0"

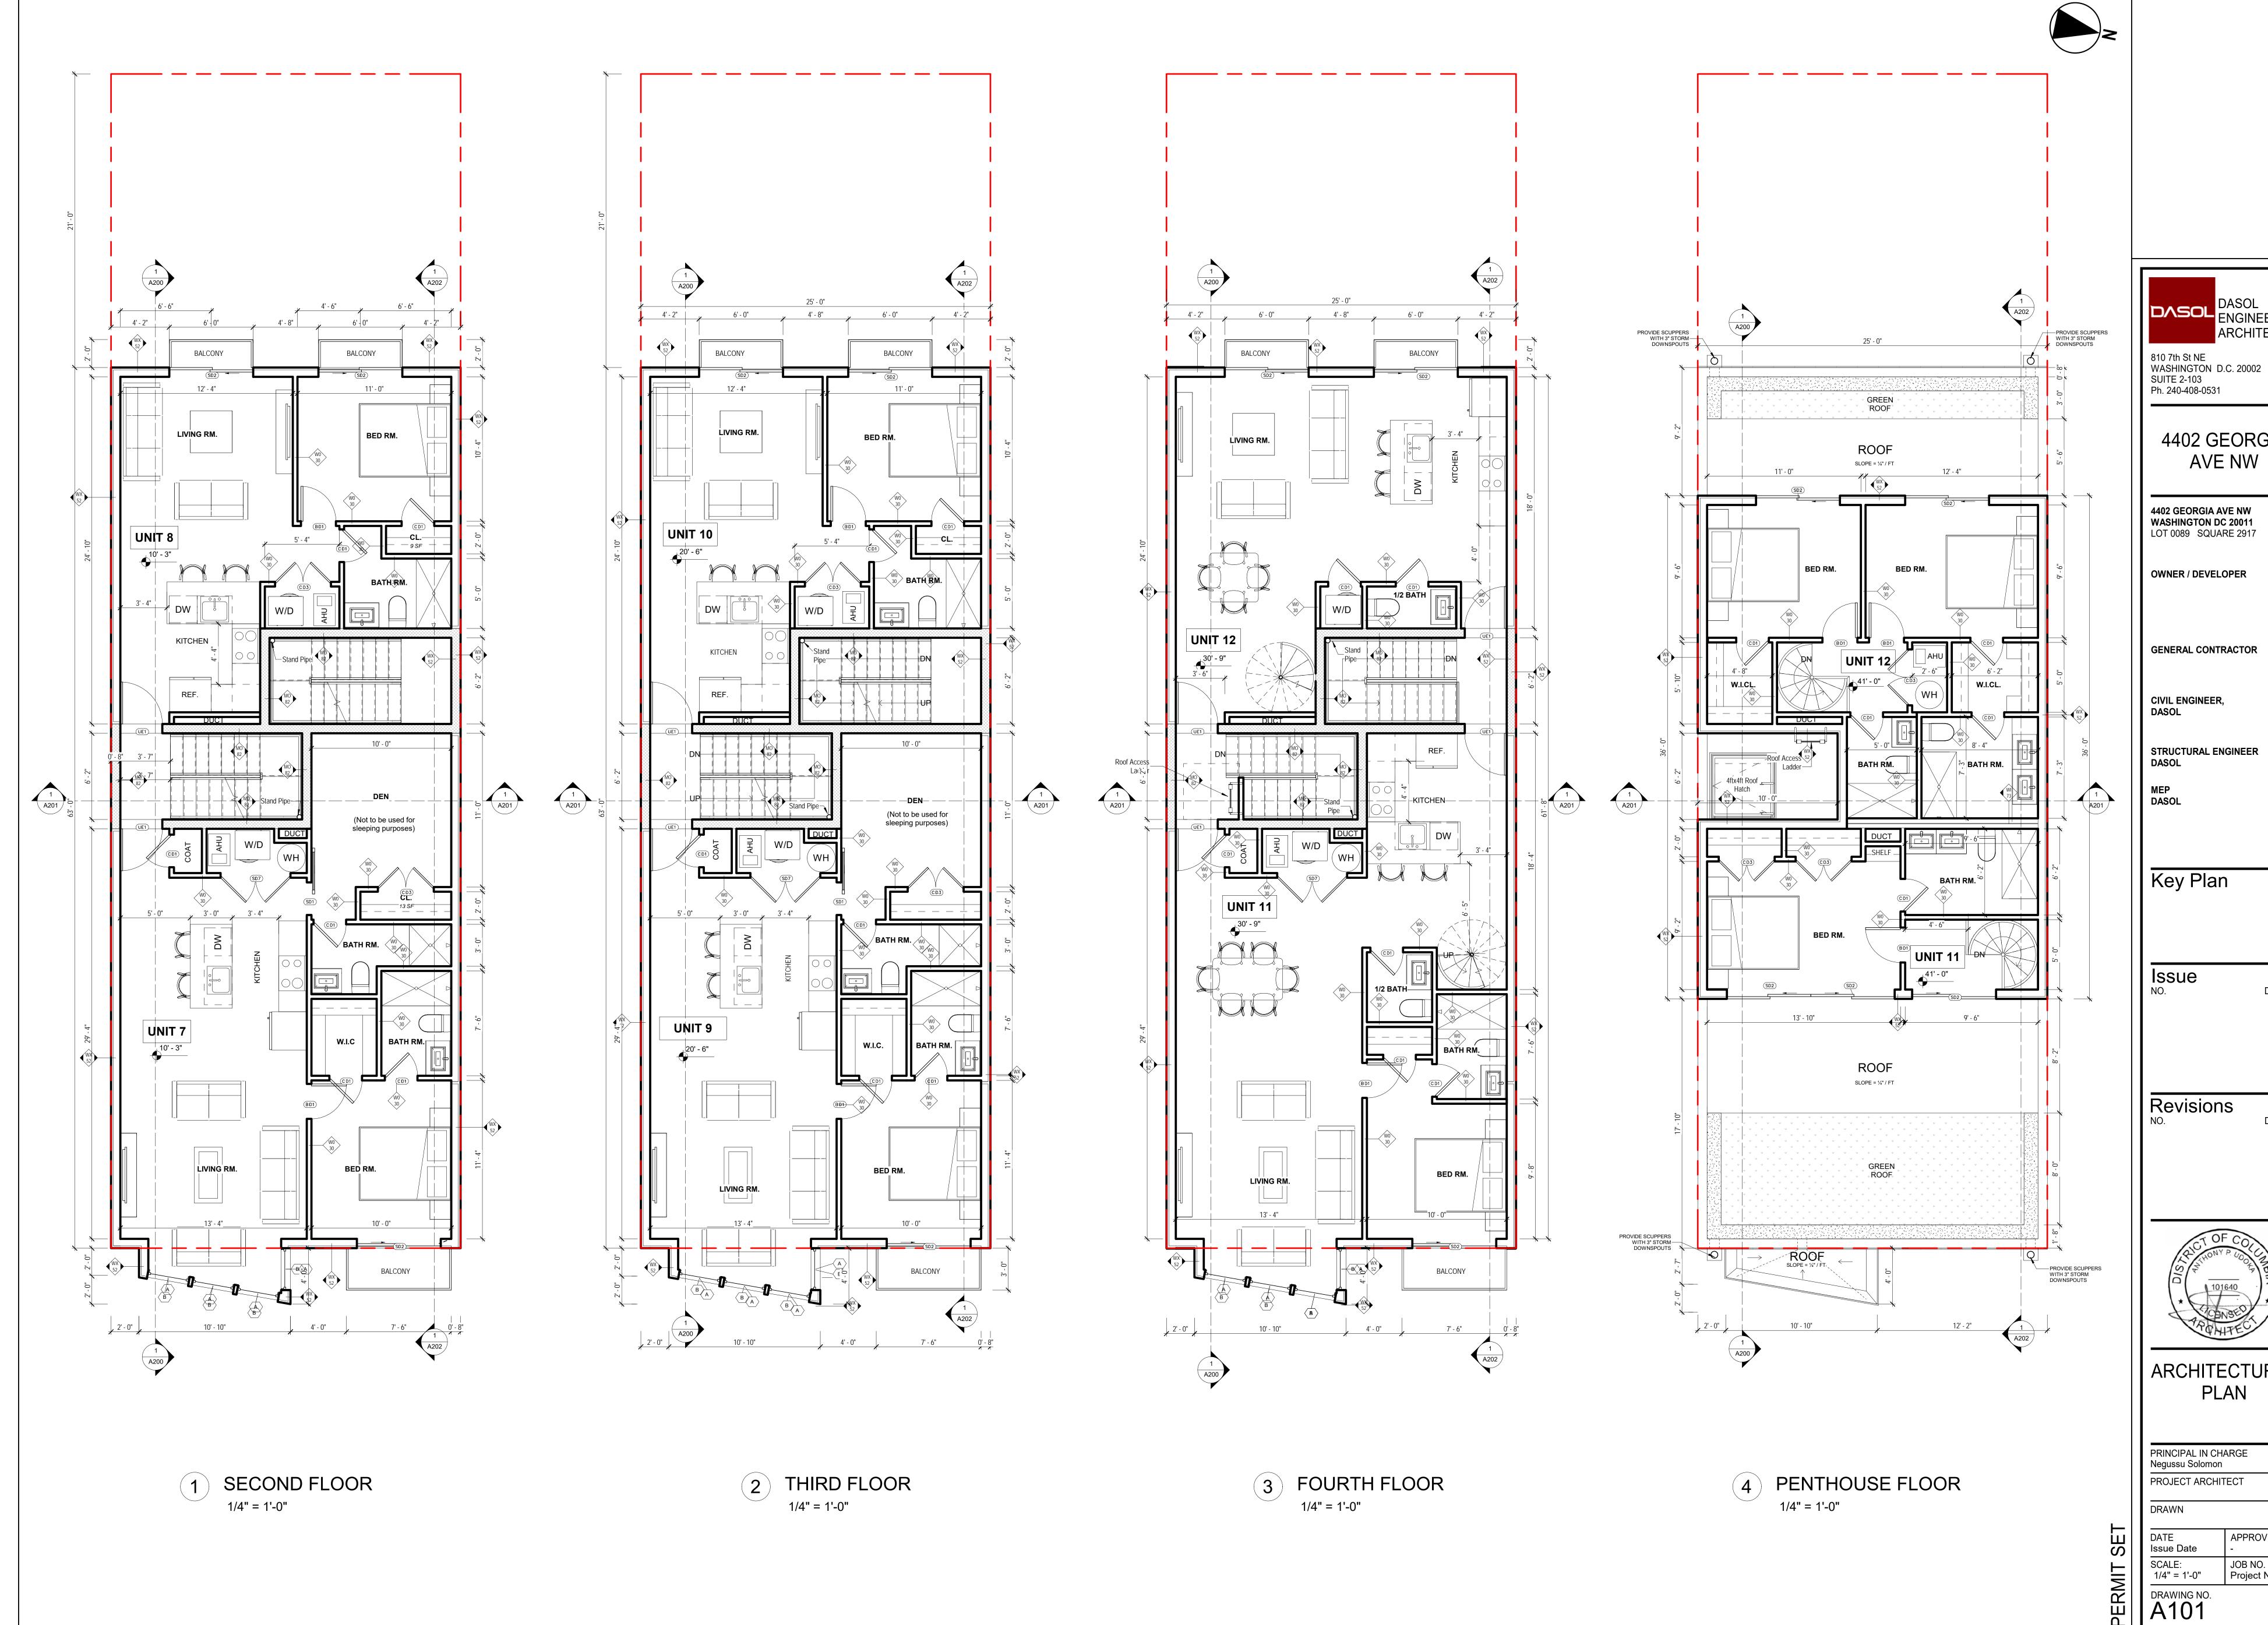

DASOL ENGINEERS ARCHITECTS

4402 GEORGIA

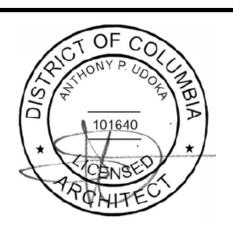


ARCHITECTURAL PLAN

PRINCIPAL IN CHARGE Negussu Solomon PROJECT ARCHITECT

APPROVED

JOB NO. Project Number

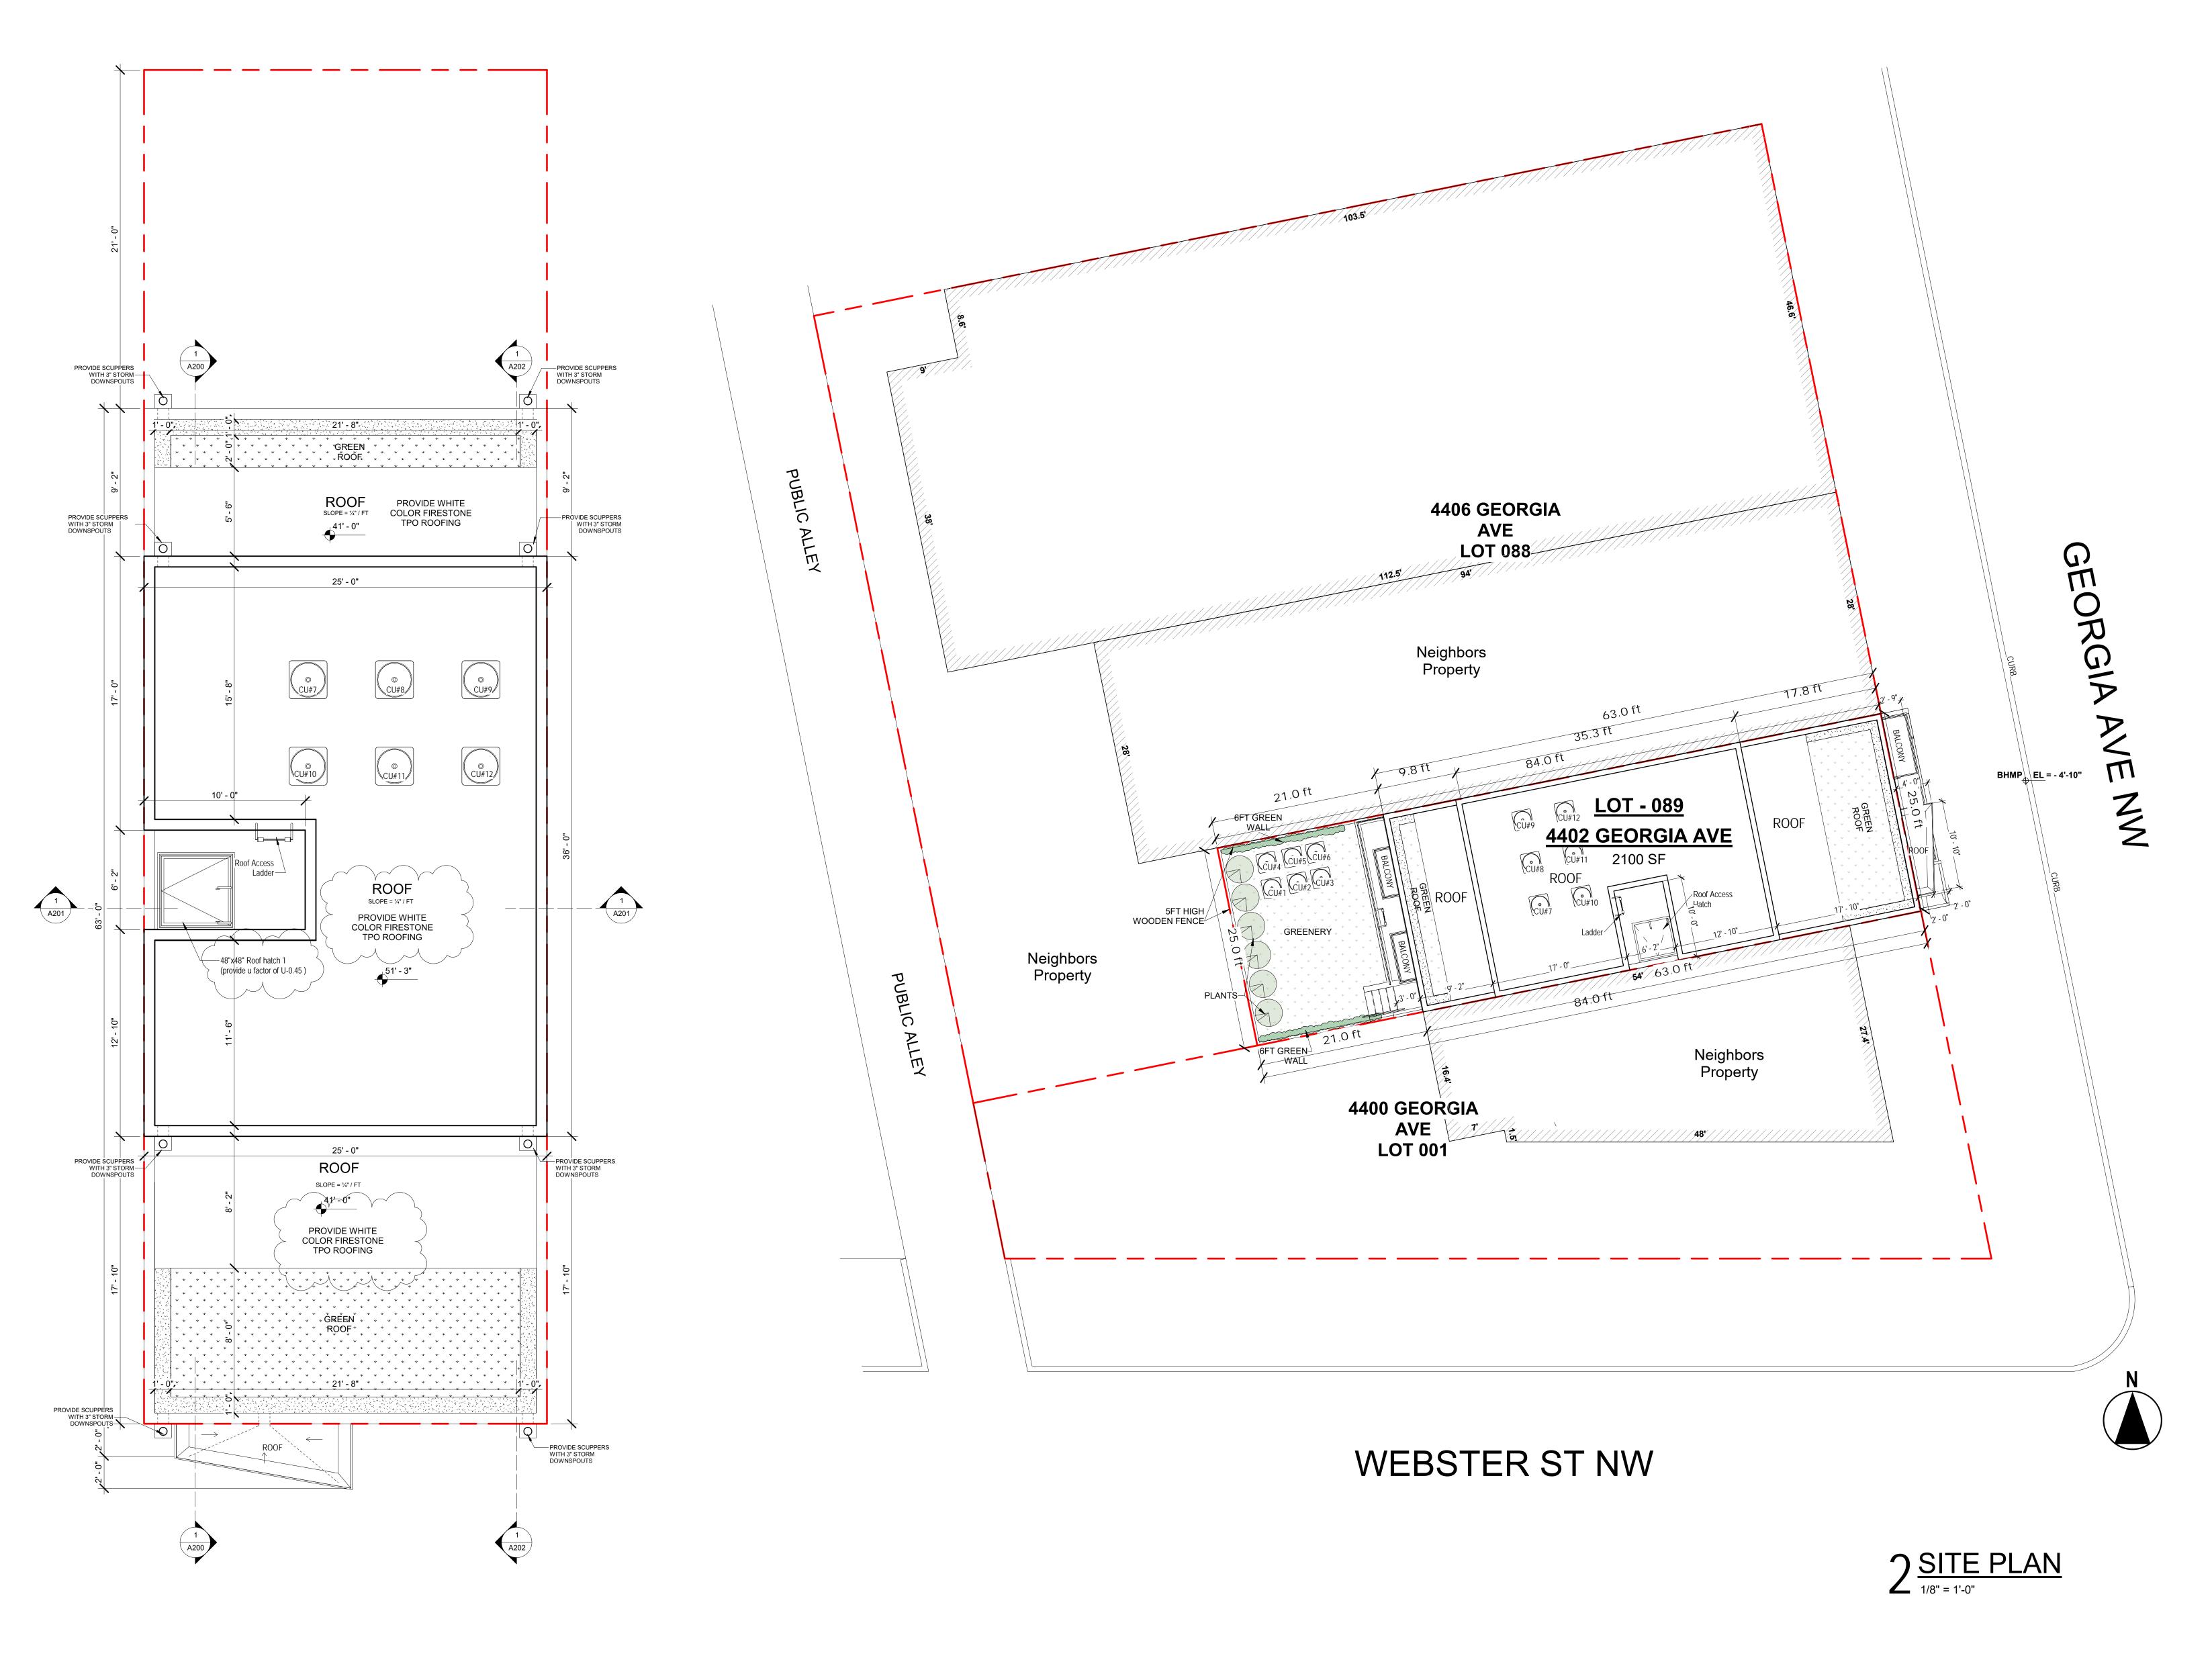

DASOL ENGINEERS ARCHITECTS

810 7th St NE

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> 4402 GEORGIA AVE NW

4402 GEORGIA AVE NW WASHINGTON DC 20011 LOT 0089 SQUARE 2917

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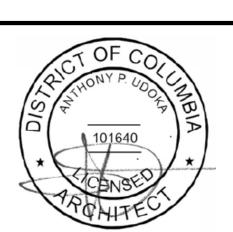
MEP DASOL

Key Plan

Issue

Revisions

1 Revision 1



ROOF & SITE PLAN

PRINCIPAL IN CHARGE Negussu Solomon PROJECT ARCHITECT

DRAWN

DATE APPROVED Issue Date SCALE: JOB NO.
As indicated Project Number

DRAWING NO. A 102

1 ROOF LEVEL